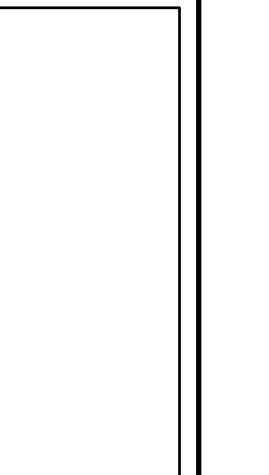


SITE LOCATION MAP



ROOSEVELT ISLAND OPERATING CORPORATION

100% CONSTRUCTION DOCUMENT FOR
**LIGHTHOUSE TOWER PLAZA
REPAVING PROJECT**

N.T.S.

AT NORTHERN END OF ROOSEVELT ISLAND,
ROOSEVELT ISLAND, NY

02/12/2021

LIST OF DRAWINGS

			<u>ADD ALTERNATE LIST</u>	
1	T-001.00	TITLE SHEET	ADD ALTERNATE 1 - EXPOSED AGGREGATE CONCRETE PAVEMENT	STANTEC CONSULTING SERVICES INC. LANDSCAPE ARCHITECTURE
2	G-001.00	GENERAL NOTES		
3	V-101.00	EXISTING CONDITIONS		
4	R-101.00	SITE PREP AND DEMO		
5	L-201.00	MATERIALS AND LAYOUT PLAN		
6	L-202.00	GRADING PLAN		
7	L-203.00	SITE DETAILS		

GENERAL NOTES:

THE FOLLOWING NOTES SHALL APPLY THROUGHOUT. EXCEPTIONS ARE SPECIFICALLY NOTED ON EACH DRAWING.

1. THE CONTRACTOR SHALL FIELD VERIFY ALL DIMENSIONS AND CONDITIONS OF THE SITE AND / OR BUILDING.
2. THE CONTRACTOR SHALL, UNLESS OTHERWISE PROVIDED IN THE CONTRACT DOCUMENTS, SECURE AND PAY FOR THE REQUIRED CONSTRUCTION PERMIT(S), FEES, LICENSES AND INSPECTIONS NECESSARY FOR THE PROPER EXECUTION OF THE WORK.
3. APPLICATION FOR CONSTRUCTION PERMITS SHALL BE PROCESSED THROUGH THE BUILDING CODE COMPLIANCE DIVISION OF THE AUTHORITY.
4. COORDINATION OF ALL WORK UNDER THIS CONTRACT SHALL BE MAINTAINED TO ENSURE THE QUALITY AND TIMELY COMPLETION OF THE WORK / PROJECT.
5. THE CONTRACTOR SHALL PERFORM ALL CUTTING AND PATCHING REQUIRED TO COMPLETE THE WORK AND / OR TO MAKE ITS PARTS FIT TOGETHER PROPERLY WITHOUT COMPROMISING THE QUALITY OF THE WORK.
6. THE CONTRACTOR SHALL BE RESPONSIBLE FOR ADEQUATELY BRACING AND PROTECTING ALL WORK DURING CONSTRUCTION AGAINST DAMAGE, BREAKAGE, COLLAPSE, DISTORTIONS, AND OFF ALIGNMENTS ACCORDING TO CODES AND STANDARDS OF GOOD PRACTICE.
7. ALL ELEVATIONS SHOWN ARE BASED ON THE NORTH AMERICAN VERTICAL DATUM OF 1988 (NAVD88) AS ESTABLISHED AND MAINTAINED BY NATIONAL GEODETIC SURVEY OF THE NATIONAL OCEAN SERVICE, NATIONAL OCEANIC AND ATMOSPHERIC ADMINISTRATION OR SUCCESSOR AGENCY.
8. WHERE MANUFACTURER'S NAMES AND PRODUCT NUMBERS ARE INDICATED ON THE DRAWINGS, IT SHALL BE CONSTRUED TO MEAN THE ESTABLISHING OF QUALITY AND PERFORMANCE STANDARDS OF SUCH ITEMS. ALL OTHER PRODUCTS MUST BE SUBMITTED TO THE OWNER'S REPRESENTATIVE FOR APPROVAL BEFORE THEY SHALL BE DEEMED EQUAL.
9. ADDITIONAL NOTES THAT ARE APPLICABLE TO THIS PROJECT MAY BE FOUND THROUGHOUT THE CONTRACT DRAWINGS.
10. THE CONTRACTOR SHALL REFER TO ALL APPLICABLE AGENCY STANDARD DETAILS.
11. IT IS MANDATORY, AS PER NYS INDUSTRIAL CODE RULE 53, FOR THE CONTRACTOR TO NOTIFY NEW YORK 811 AT LEAST FORTY-EIGHT (48) HOURS BEFORE COMMENCING EXCAVATION. THE EMAIL ADDRESS IS EMAIL@NEWYORK811INC.COM AND THE WEB SITE IS [HTTP://NEWYORK-811.COM](http://NEWYORK-811.COM).

REMOVAL NOTES

1. IT IS THE CONTRACTOR'S RESPONSIBILITY TO VERIFY ALL EXISTING SITE CONDITIONS, BOTH ABOVE AND BELOW THE SURFACE, PRIOR TO COMMENCING WORK. ANY DISCREPANCIES BETWEEN THE INFORMATION SHOWN ON THE DRAWINGS AND ACTUAL FIELD CONDITIONS SHALL BE BROUGHT TO THE ATTENTION OF THE OWNER'S REPRESENTATIVE IN WRITING PRIOR TO COMMENCING WORK.
2. THE CONTRACTOR SHALL COMPLY WITH ALL APPLICABLE CODES AND REGULATIONS GOVERNING THIS WORK. THE CONTRACTOR SHALL COORDINATE DEMOLITION WITH APPLICABLE AGENCIES, UTILITY COMPANIES, AND / OR SUB-CONTRACTORS.
3. IT IS MANDATORY, AS PER NYS INDUSTRIAL CODE RULE 53, FOR THE CONTRACTOR TO NOTIFY THE NEW YORK CITY / LONG ISLAND ONE-CALL CENTER, 36-35 BELL BOULEVARD, SUITE 202, BAYSIDE, NY 11361, TEL 800.272.448 IN ADDITION TO ALL UNDERGROUND FACILITY OPERATORS IN THE AREA WHO ARE NOT ONE-CALL MEMBERS, NOT LESS THAN TWO (2) FULL BUSINESS DAYS AND NOT MORE THAN TEN (10) FULL BUSINESS DAYS BEFORE COMMENCING EXCAVATION. THE ONE-CALL CENTER IS ALWAYS OPEN. THE ONE-CALL CENTER WILL THEN NOTIFY MEMBER FIRMS WITH OPERATIONS IN THE SITE AREA OF THE CONTRACTOR'S PENDING EXCAVATION OPERATIONS. THE CONTRACTOR WILL RECEIVE A NOTIFICATION TICKET FROM THE ONE-CALL CENTER WHICH SHOULD BE PRESENTED TO THE OWNER'S REPRESENTATIVE AS PROOF OF THE CALL. THERE IS NO CHARGE FOR THIS SERVICE. THIS PROCESS ENSURES THAT UTILITY SERVICE LINES ARE PROPERLY MARKED PRIOR TO EXCAVATION TO MINIMIZE FACILITY DAMAGE, ON THE JOB INJURIES, AND CONTRACTOR'S LIABILITY.
4. IT SHALL BE THE CONTRACTOR'S RESPONSIBILITY TO REPAIR ANY DAMAGE AND / OR RESTORE ANY INTERRUPTION TO ANY UTILITY SERVICE THAT MAY BE CAUSED BY THE CONTRACTOR'S CONSTRUCTION OR EQUIPMENT, AT THE CONTRACTOR'S EXPENSE, WITH NO ADDITIONAL EXPENSE TO RIOC.
5. THE CONTRACTOR IS TO USE CARE DURING CONSTRUCTION TO AVOID DISTURBING OR DAMAGING ADJACENT ABOVE-GRADE OR SUBGRADE STRUCTURES, FACILITIES, CURBS, PAVEMENTS, AND PERIMETER FENCING. ANY DAMAGE RESULTING FROM THIS WORK WILL BE RESTORED TO THE SATISFACTION OF THE OWNER'S REPRESENTATIVE AT THE CONTRACTOR'S EXPENSE.
6. WHERE NEW CONSTRUCTION ABUTS EXISTING PAVEMENTS, CURBS, OR WALLS, THE EXISTING MATERIALS SHALL BE CLEANLY SAWCUT TO PROVIDE A CLEAN, NEAT MATCH AND A SMOOTH, FLUSH TRANSITION, AS DIRECTED BY THE OWNER'S REPRESENTATIVE. ALL SAWCUTTING SHALL BE DONE TO NEAT, STRAIGHT, AND ACCURATE LINES. CONTRACTOR SHALL PROVIDE EXPANSION JOINTS (TIE ROD AND / OR SLIP JOINT) WHERE OLD AND NEW CURBS MEET.
7. THE CONTRACTOR SHALL TAKE EXTREME CARE TO PROTECT THE ROOT SYSTEMS OF EXISTING TREES. BULK MATERIAL, EQUIPMENT, OR VEHICLES SHALL NOT BE STOCKPILED OR PARKED WITHIN THE DRIPLINE OF ANY TREE.
8. THE CONTRACTOR SHALL DISPOSE OF ALL ITEMS AND MATERIALS REMOVED AND NOT SALVAGED, INCLUDING ALL EXCAVATED MATERIAL, OFF-SITE AND IN A LEGAL MANNER.
9. THE CONTRACTOR IS RESPONSIBLE FOR OBTAINING ALL NECESSARY PERMITS FROM THE APPROPRIATE AGENCIES PRIOR TO COMMENCING WORK.
10. REMOVE AND STOCKPILE EXISTING PAVERS FOR REUSE. CONTRACTOR TO COORDINATE PAVER STOCKPILE LOCATION WITH OWNER'S REPRESENTATIVE.
11. CONTRACTOR SHALL CONFIRM EXAMPLE PAVERS TO BE STOCKPILED AND PAVERS TO BE DISPOSED OF WITH OWNER'S REPRESENTATIVE. PAVERS TO BE STOCKPILED SHALL BE FULL UNITS WITH NO CHIPS, CRACKS, SPALLS OR CUT PIECES, AND BE CLEANED OF DEBRIS. ALL EXISTING CUT PIECES AND OTHERWISE DAMAGED PIECES SHALL BE REMOVED AND DISPOSED.
12. ALL STOCKPILED PAVERS SHALL BE STORED ON PALLETS ELEVATED OFF THE GROUND.
13. REMOVE AND DISPOSE OF EXISTING AGGREGATE SUBBASE.
14. DEBRIS SHALL NOT BE BURIED ON THE SUBJECT SITE. ALL UNSUITABLE MATERIALS AND DEBRIS SHALL BE DISPOSED OF LEGALLY IN ACCORDANCE WITH LOCAL TOWN, COUNTY, STATE AND FEDERAL LAWS AND APPLICABLE CODES.
15. THE CONTRACTOR SHALL REMOVE, EXCAVATE, AND DISPOSE OF ALL MATERIALS ACCORDING TO

CONTRACT SPECIFICATIONS.

16. THERE ARE HISTORIC ELEMENTS ON SITE SUCH AS STONE BOLLARDS THAT NEED TO BE REMOVED, STOCKPILED, PROTECTED AND RESET.

LAYOUT & MATERIAL NOTES

1. NO CHANGES SHALL BE MADE TO THE DESIGN OR LAYOUT WITHOUT THE WRITTEN APPROVAL OF THE OWNER'S REPRESENTATIVE. LAYOUT THE WORK AS DIMENSIONED ON THE PLANS. WRITTEN DIMENSIONS SHALL GOVERN. DO NOT SCALE DISTANCES.
2. CONTRACTOR SHALL LAYOUT IN THE FIELD THE ALIGNMENT AT ALL PATHS, PAVEMENTS AND CURBLINES FOR REVIEW BY THE OWNER'S REPRESENTATIVE. ADJUSTMENTS MAY BE MADE ONLY AS DIRECTED BY THE OWNER'S REPRESENTATIVE. CONTRACTOR MAY NOT PROCEED WITH CONSTRUCTION OF IMPROVEMENTS UNTIL HE HAS RECEIVED THE FINAL APPROVAL OF THE LAYOUT FROM THE OWNER'S REPRESENTATIVE.
3. ALL NEW PAVEMENTS AND CURBS AND EXISTING PAVEMENTS AND CURBS TO REMAIN SHALL MEET IN SMOOTH FLUSH CONDITION UNLESS NOTED OTHERWISE.
4. NEW CURBS, WALLS, AND PAVEMENTS SHALL BE BUILT TO A SMOOTH EVEN FINISH WITH A CONSISTENT TOP AND PROFILE WITHOUT WAVES OR IRREGULARITIES. ANY WORK NOT MEETING THIS QUALITY STANDARD SHALL BE REPLACED AT THE CONTRACTOR'S EXPENSE.
5. THE CONTRACTOR SHALL EXERCISE CARE DURING EXCAVATION OPERATIONS TO AVOID DISTURBING ADJACENT FACILITIES, SUB GRADE STRUCTURES AND TREES. ALL DAMAGE RESULTING FROM THE CONSTRUCTION SHALL BE THE CONTRACTOR'S RESPONSIBILITY AND SHALL BE REPAIRED AT NO EXPENSE TO RIOC. ALL REPAIR WORK SHALL BE TO THE SATISFACTION OF THE OWNER'S REPRESENTATIVE.

LANDSCAPE PROTECTION NOTES

1. IT IS THE CONTRACTOR'S RESPONSIBILITY TO CHECK AND VERIFY ALL SITE CONDITIONS, BOTH ABOVE AND BELOW THE SURFACE, PRIOR TO COMMENCING WORK. ANY DISCREPANCIES BETWEEN INFORMATION SHOWN ON THE DRAWINGS AND ACTUAL FIELD CONDITIONS SHOULD BE BROUGHT TO THE ATTENTION OF THE OWNER'S REPRESENTATIVE IN WRITING, PRIOR TO THE COMMENCEMENT OF WORK.
2. THE CONTRACTOR SHALL BE RESPONSIBLE FOR THE PROTECTION AND PRESERVATION OF ALL EXISTING PLANT MATERIAL AND LAWNS THAT ARE TO BE RETAINED WITHIN CONTRACT LIMIT LINE.

DRAINAGE WORK NOTES:

1. CONTRACTOR SHALL PROVIDE TEMPORARY MEANS (PIPES, PUMPS, ETC.) TO DRAIN ANY STORM WATER WHICH MAY DEVELOP WITHIN THE PROJECT LIMITS FOR THE DURATION OF CONSTRUCTION. CONTRACTOR SHALL SUBMIT A DRAINAGE SCHEME WHICH MUST BE APPROVED BY THE OWNER'S REPRESENTATIVE, PRIOR TO THE START OF EACH CONSTRUCTION STAGE. COST OF THIS WORK WILL BE DEEMED TO HAVE BEEN INCLUDED IN THE PRICE BID FOR ALL SCHEDULED ITEMS.

SOIL EROSION AND SEDIMENT CONTROL NOTES:

A. GENERAL

1. ALL SEDIMENT AND EROSION CONTROL MEASURES SHALL BE INSTALLED PRIOR TO ANY MAJOR SOIL DISTURBANCE, OR IN THEIR PROPER SEQUENCE, AND MAINTAINED UNTIL PERMANENT PROTECTIONS ARE ESTABLISHED. CONTRACTOR SHALL COMPLY WITH ALL PHASE II STORM WATER REQUIREMENTS.
2. ALL WORK SHALL BE DONE IN ACCORDANCE WITH THE STANDARDS FOR SOIL EROSION AND SEDIMENT CONTROL IN THE STATE OF NEW YORK.
3. CONTRACTOR SHALL OBTAIN ALL REQUIRED PERMITS.
4. ALL SOIL EROSION AND SEDIMENT CONTROL DEVICES SHALL BE LOCATED IN THE FIELD AS REQUIRED OR AT THE DIRECTION OF THE OWNER'S REPRESENTATIVE. THE CONTRACT DRAWINGS ARE NOT INTENDED TO SHOW THE LOCATION AND DETAILS FOR ALL SUCH DEVICES BUT ARE TO BE USED AS A REASONABLE GUIDE.
5. ALL SEDIMENT AND EROSION CONTROL PRACTICES ARE TO BE INSTALLED PRIOR TO ANY MAJOR SOIL DISTURBANCE OR IN THEIR PROPER SEQUENCE, AND MAINTAINED THROUGHOUT THE PROJECT.
6. DEMOLITION ACTIVITIES SHALL BE DONE IN A MANNER THAT MINIMIZES THE AREA OF UNSTABILIZED SOIL WITHIN THE SITE.
7. FREQUENT WATERING WILL BE REQUIRED TO PREVENT WIND EROSION AND TO MINIMIZE THE PRODUCTION OF DUST DURING CONSTRUCTION ACTIVITIES.
8. THE CONTRACTOR SHALL PROVIDE A STABILIZED CONSTRUCTION EXIT AS PER NYSDEC STANDARDS AND SPECIFICATIONS AT SPECIFIED INGRESS AND EGRESS POINTS FOR THE PROJECT SITE. ACCESS/EGRESS SHALL BE COORDINATED WITH THE CONTRACTOR'S SITE LOGISTICS PLAN.
9. PRIOR TO DEMOLITION/ABANDONMENT OF STORM UTILITIES, PROPOSED DRAINAGE FACILITIES SHALL BE INSTALLED TO ALLOW THE STORM FLOW TO BE TRANSPORTED TO THE EXISTING OUTLETS WITHOUT ERODING THE SITE.
10. CONTRACTOR SHALL PHASE CONSTRUCTION IN ORDER TO MINIMIZE SOIL EROSION.
11. ADJACENT PAVED WORK AREAS, SIDEWALKS, PEDESTRIAN WALKWAYS ARE TO BE INSPECTED DAILY AND SHALL BE SWEEPED AS NECESSARY TO REMOVE EXCESS DIRT, MUD, OR DEBRIS TRACKED FROM THE SITE. DUMP TRUCKS HAULING MATERIAL FROM THE CONSTRUCTION SITE SHALL BE COVERED BY TARPAULIN.
12. THE CONTRACTOR SHALL BE RESPONSIBLE FOR MAINTAINING ALL SEDIMENTATION AND EROSION CONTROL DEVICES AND PROVIDING ANY ADDITIONAL DEVICES DEEMED NECESSARY BY THE OWNER DURING CONSTRUCTION.
13. UPON COMPLETION OF THE PROJECT ALL AREAS WITHIN THE PROJECT WORK AREA SHALL BE STABILIZED AS WELL AS ANY AREAS LEFT DENUDED FOR MORE THAN 14 DAYS.
14. TEMPORARY PARKING AND STORAGE AREAS WHICH SHALL BE USED AS THE EQUIPMENT MAINTENANCE AND CLEANING AREA FOR LOCATING PORTABLE FACILITIES, OFFICE TRAILERS, AND TOILET FACILITIES SHALL BE INCORPORATED FROM CONTRACTOR'S WORK PLAN.
15. ALL WASH WATER FROM CONCRETE TRUCKS, VEHICLE CLEANING, EQUIPMENT CLEANING, ETC. SHALL BE DETAILED AND PROPERLY TREATED OR DISPOSED. NO WASH WATER CAN BE DISCHARGED INTO THE EAST RIVER OR ANY DRAINAGE SYSTEM TRIBUTARY TO THE RIVER.
16. RUBBISH, TRASH GARBAGE, LITTER OR OTHER SUCH MATERIALS SHALL BE DEPOSITED INTO SEALED CONTAINERS. MATERIALS SHALL BE PREVENTED FROM LEAVING THE PREMISES THROUGH THE ACTION OF WIND OR STORMWATER DISCHARGE INTO DRAINAGE DITCHES OR WATERS OF THE STATE.



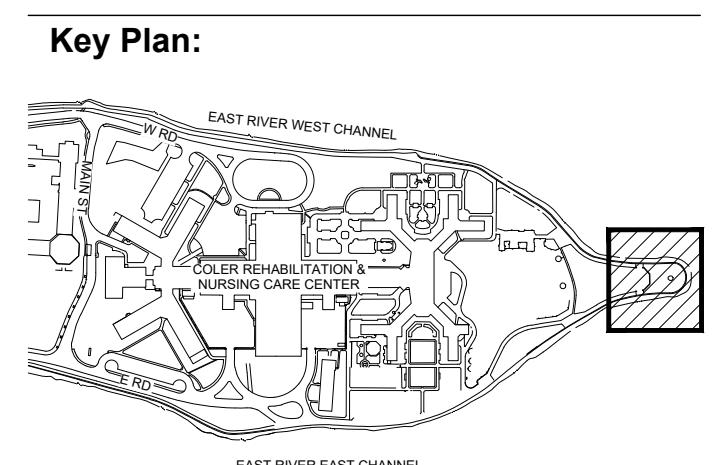
Project Title:

LIGHTHOUSE TOWER PLAZA REPAVING PROJECT

Project Address:
755 Main Street
Roosevelt Island, NY 10044

Project Team:
OWNER
Roosevelt Island Operating Corporation
591 Main Street
Roosevelt Island, NY 10044

LANDSCAPE ARCHITECTS
Stantec
475 Fifth Avenue 12th Floor
New York, NY 10017
(T) 212 366 5600



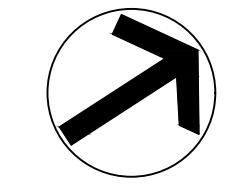
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Revision: Date: Issued To:

Drawing Title:
GENERAL NOTES

NOT FOR CONSTRUCTION

Project No.:
Scale: NTS
Date: 02/12/2021
Seal: Drawing No.:
G-001.00
Page: 2 of 7



Project Title:

**LIGHTHOUSE TOWER
PLAZA REPAVING
PROJECT**

 Project Address:
755 Main Street
Roosevelt Island, NY 10044

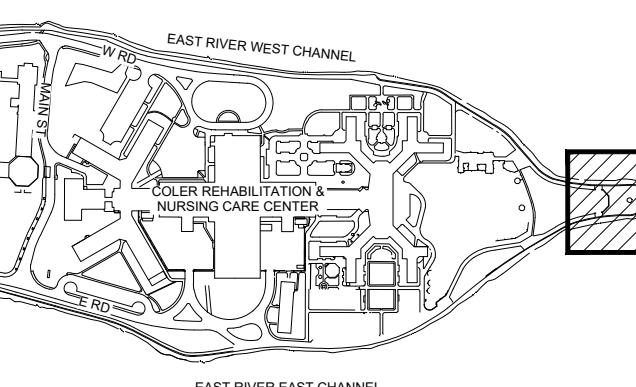
Project Team:

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LANDSCAPE ARCHITECTS

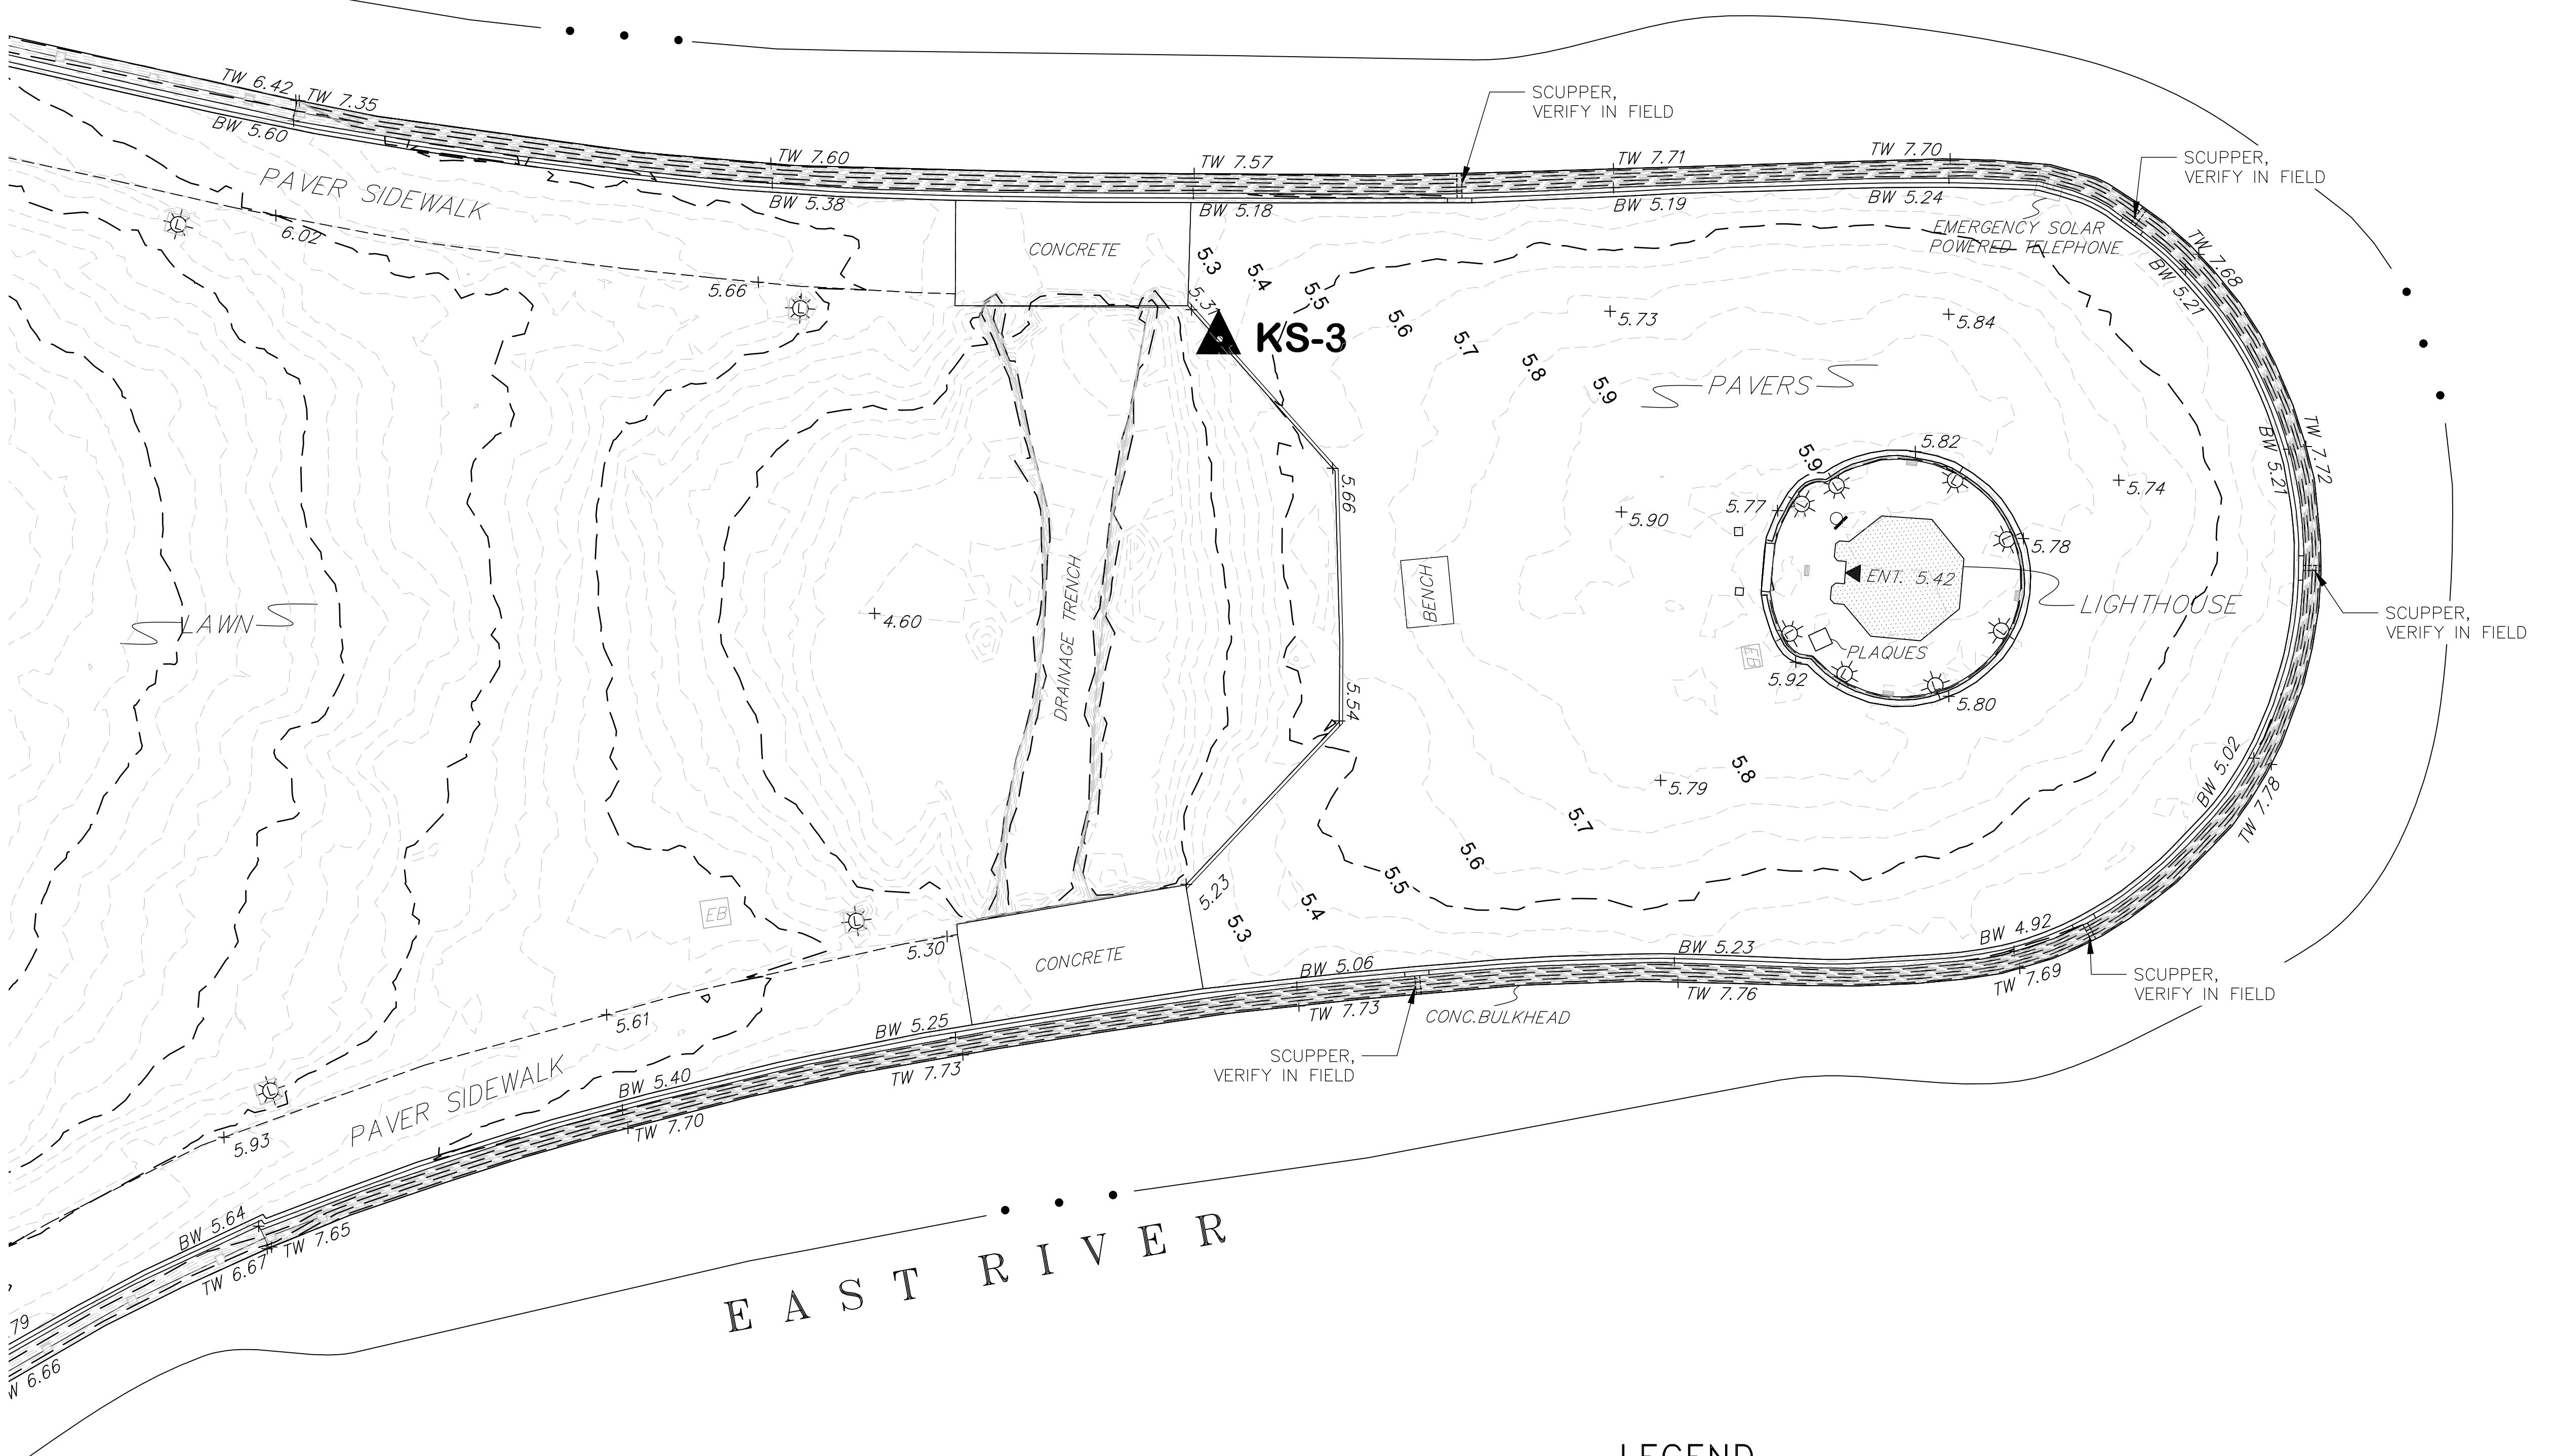
 Stantec
475 Fifth Avenue 12th Floor
New York, NY 10017
(T) 212 366 5600

Key Plan:

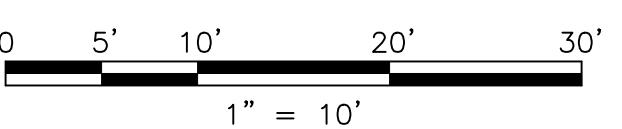

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LOT: 1


REVISION: DATE: ISSUED TO:

 Drawing Title:
EXISTING CONDITIONS

E A S T R I V E R

LEGEND
ABBREVIATION

BUILDING	BLD.	BUILDING
BOTTOM	BOT.	BUILDING HATCH
BOTTOM OF CURB	BC	BUILDING HATCH
BOTTOM OF WALL	BW	WALL TOP
CONCRETE	CONC.	WALL BOTTOM
CHAIN LINK FENCE	C.L.F.	WALL BOTTOM
DROP CURB	DC	TREE & TRUNK DIAMETER
ENTRANCE	ENT.	8312"	(TREE)
GRADE	GR	8312"	(SHRUB)
INVERT	INV.	CON./SW LINE
SIDEWALK	SW	CONTOUR MAJOR	— — — — —
TOP OF WALL	TW.	CONTOUR MINOR	— — — — —
TOP OF CURB	TC	CONTOUR MINOR	— — — — —



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Project Team:

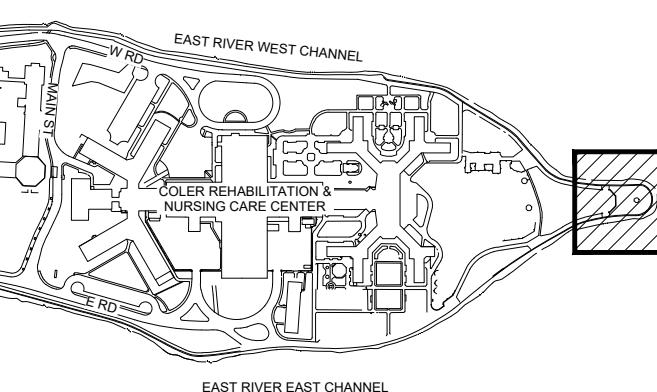
OWNER

Roosevelt Island Operating Corporation
591 Main Street
Roosevelt Island, NY 10044

LANDSCAPE ARCHITECTS

Stantec
475 Fifth Avenue 12th Floor
New York, NY 10017
(T) 212 366 5600

Key Plan:



**BLOCK: 137
LOT: 1**

REVISION: **DATE:** **ISSUED TO:**

Drawing Title:

LEGEND

<input type="checkbox"/> TEL	PAY PHONE		CONTRACT LIMIT LINE		PROP. SILT SACK FOR CATCH BA
<input type="checkbox"/> EB	ELECTRIC BOX		SITE WORK LIMIT		PROP. CONSTRUCTION GATE
 KS-3	CONTROL POINT		CONSTRUCTION FENCE		SITE ACCESS
	STREET LIGHT		REMOVE AND STOCKPILE EXISTING PAVERS		
<input type="checkbox"/> COLUMN					
	SIGN				

A diagram of a telescope. The main body is a long, thin cylinder with a black cap on the left and a eyepiece on the right. A scale bar is positioned below the telescope, with markings at 0, 5', 10', 20', and 30'. Below the scale bar, the text "1'' = 10'" is written.

NOT FOR CONSTRUCTION

Project No.:

Scale: 1"=10'

Date: 03/13/2021

Seal:

R-101.00

Page:4 of 7

Project Title:

**LIGHTHOUSE TOWER
PLAZA REPAVING
PROJECT**

 Project Address:
755 Main Street
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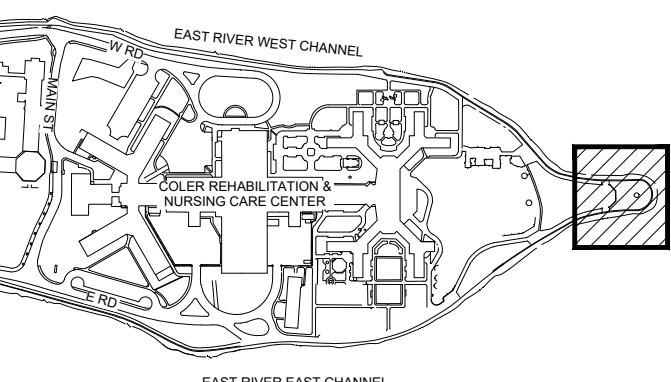
Project Team:

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Roosevelt Island Operating Corporation
591 Main Street
Roosevelt Island, NY 10044

LANDSCAPE ARCHITECTS

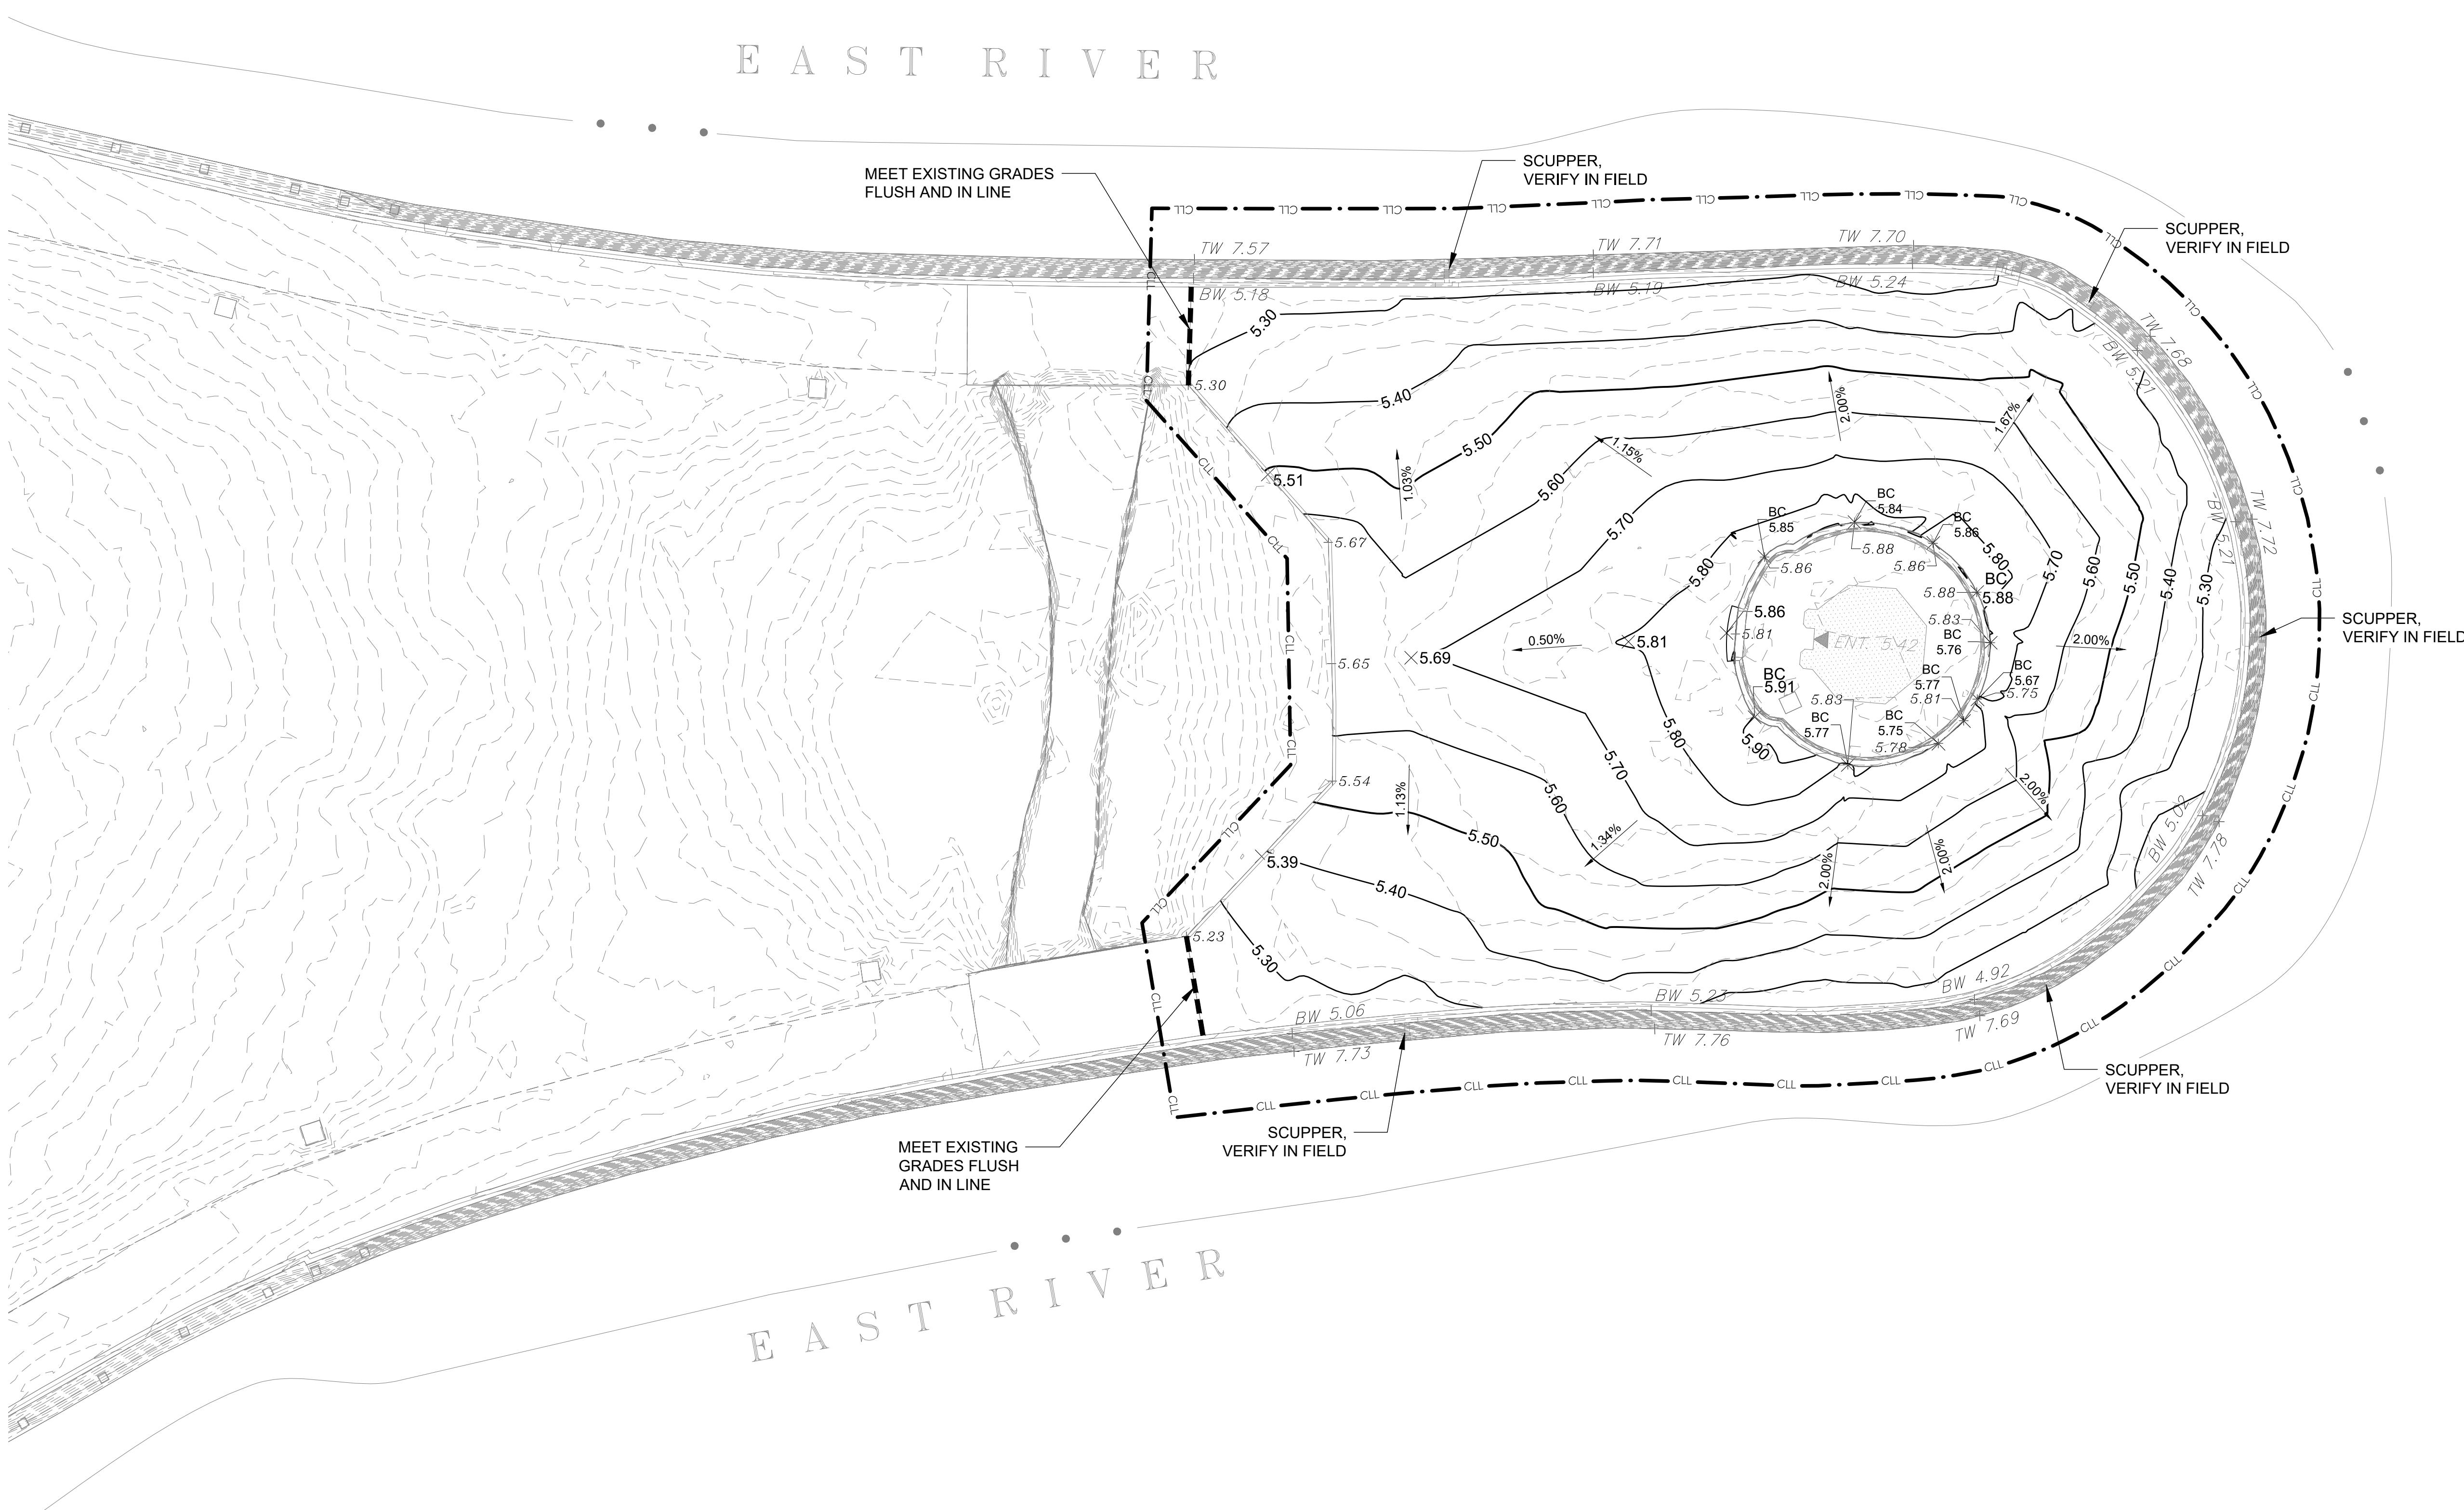
 Stantec
475 Fifth Avenue 12th Floor
New York, NY 10017
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Key Plan:

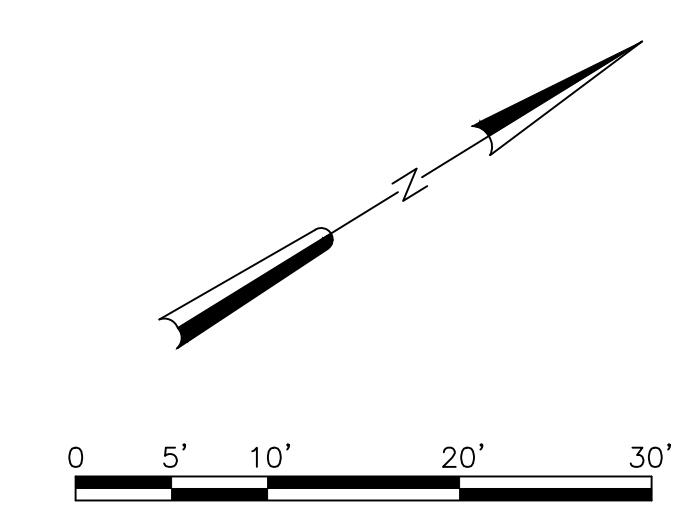

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LOT: 1

REVISION: DATE: ISSUED TO:

 Drawing Title:
GRADING PLAN

E A S T R I V E R

LEGEND

-----	SITE WORK LIMIT
XX	MAJOR TENTH OF A CONTOUR
XX	MINOR TENTH OF A CONTOUR
XX	EXISTING TENTH OF A CONTOUR
TC	TOP OF CURB
BC	BOTTOM OF CURB
XX.XX	SPOT ELEVATION
+XX.XX	EXISTING ELEVATION



NOT FOR CONSTRUCTION

Project No.:	
Scale:	1"=10'
Date:	02/12/2021
Seal:	Drawing No.:
	L-202.00
	Page: 6 of 7

Project Title:

**LIGHTHOUSE TOWER
PLAZA REPAVING
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 755 Main Street
 Roosevelt Island, NY 10044

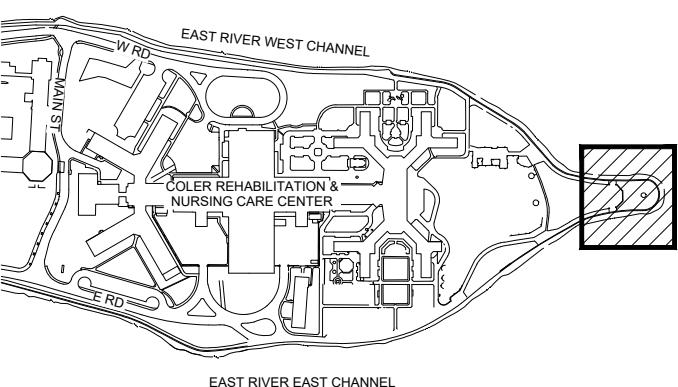
Project Team:

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 Roosevelt Island Operating Corporation
 591 Main Street
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LANDSCAPE ARCHITECTS

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 475 Fifth Avenue 12th Floor
 New York, NY 10017
 (T) 212 366 5600

Key Plan:


 BLOCK: 1373
 LOT: 1

REVISION: DATE: ISSUED TO:

 Drawing Title:
 SITE DETAILS

NOT FOR CONSTRUCTION

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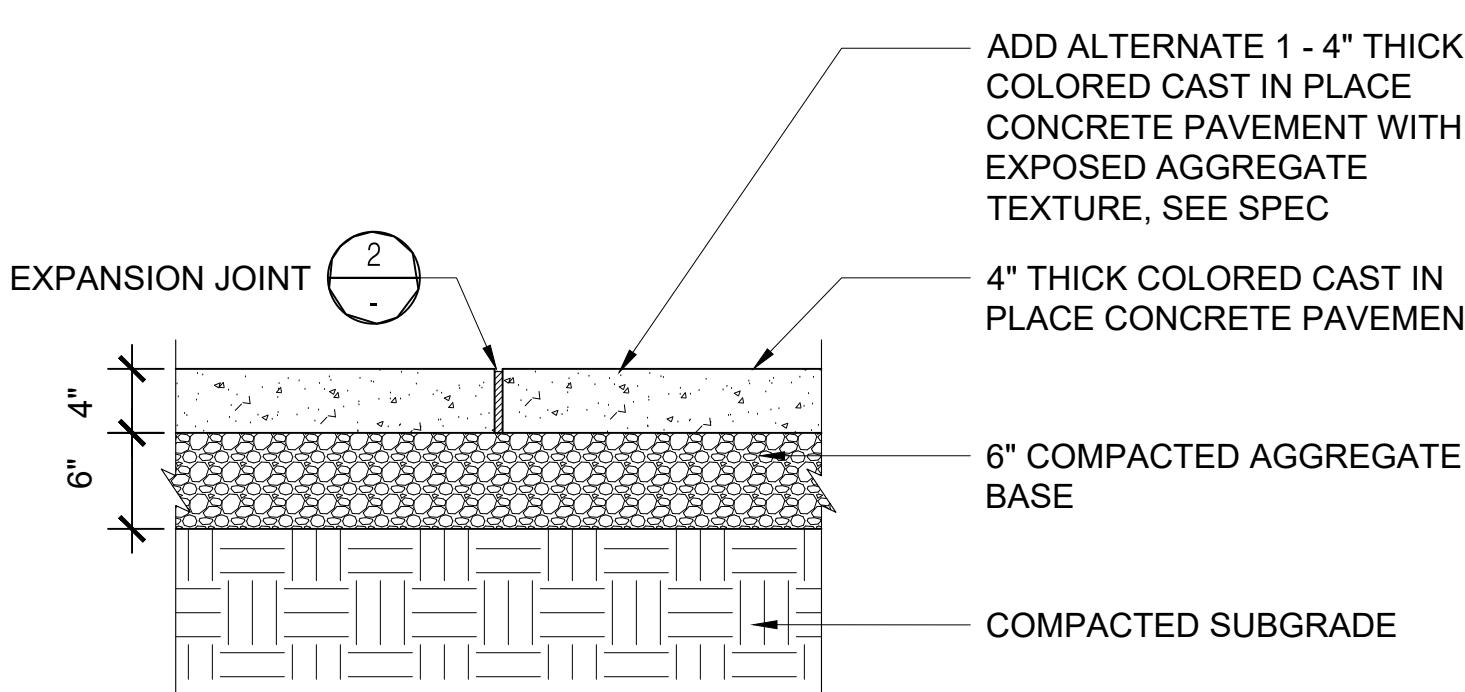
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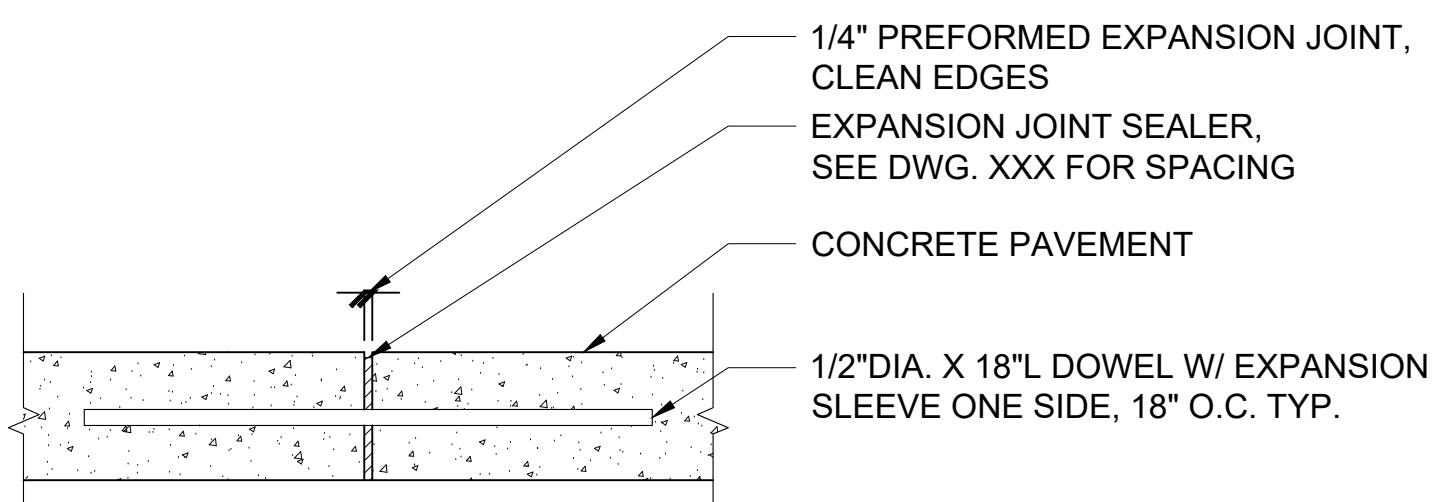
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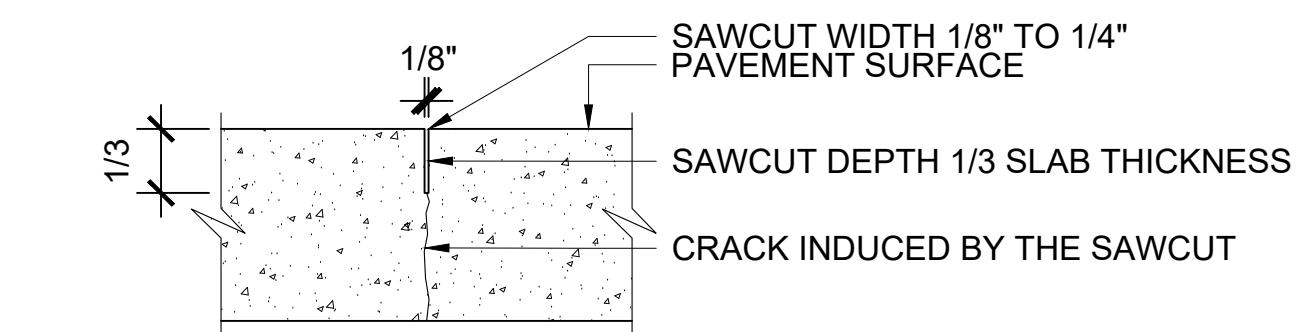
Page: 7 of 7


1 COLORED CAST IN PLACE CONCRETE PAVEMENT

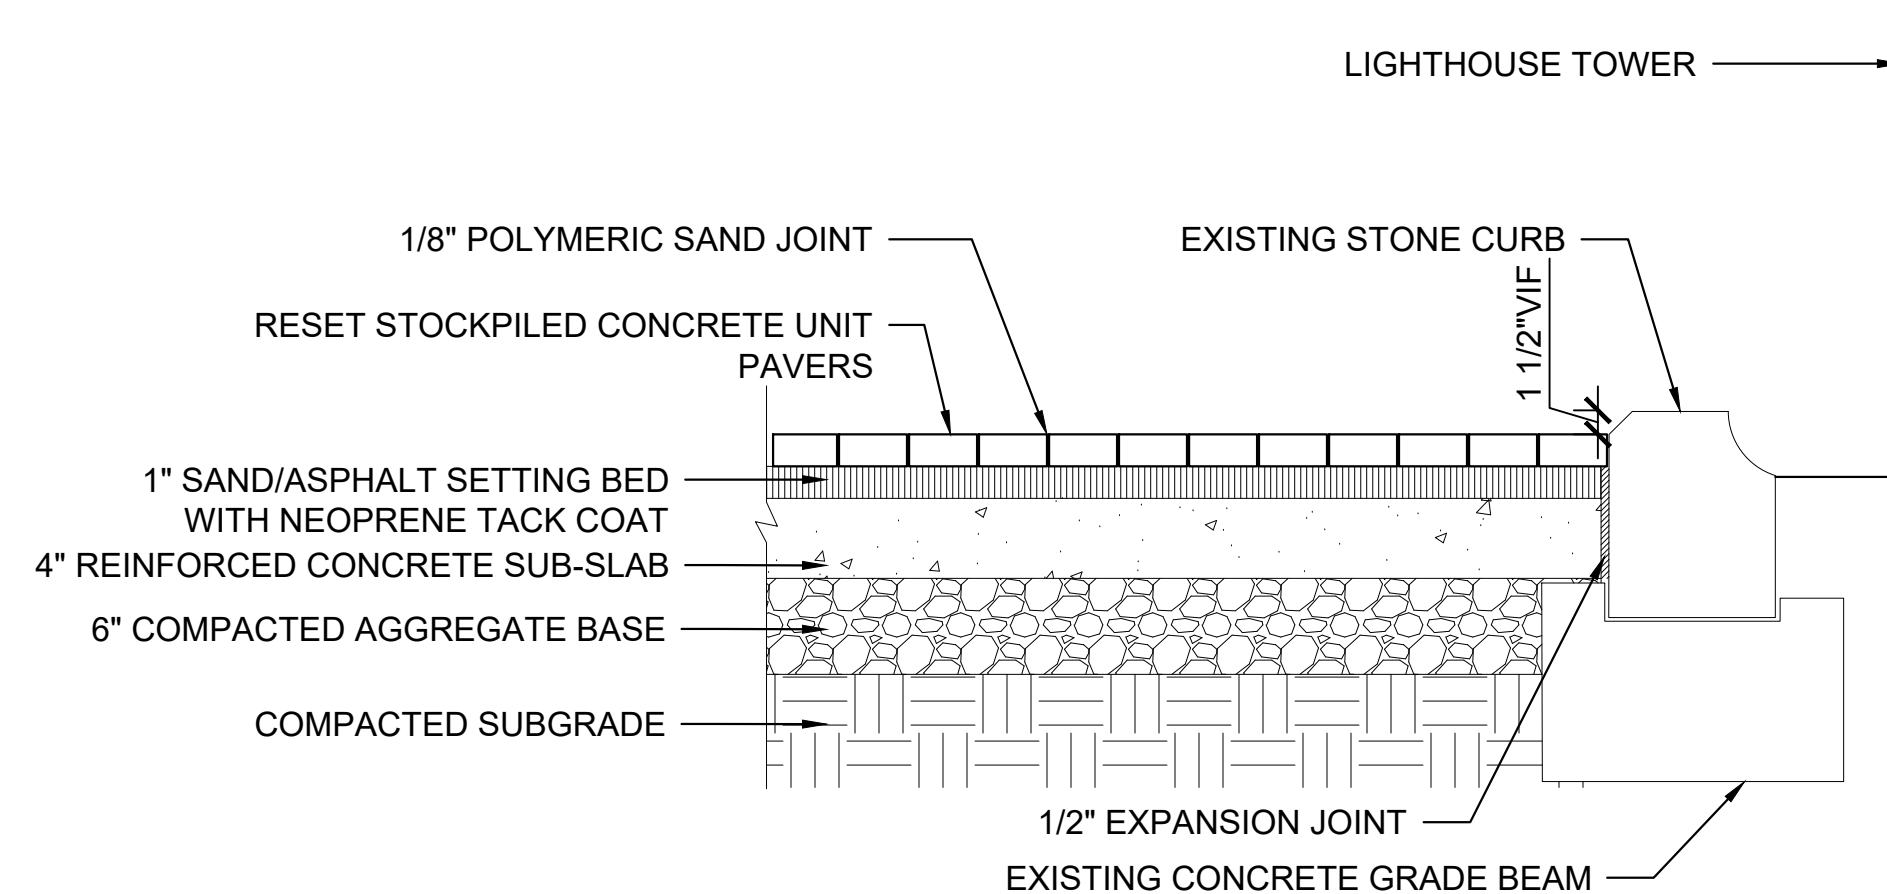
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2 EXPANSION JOINT

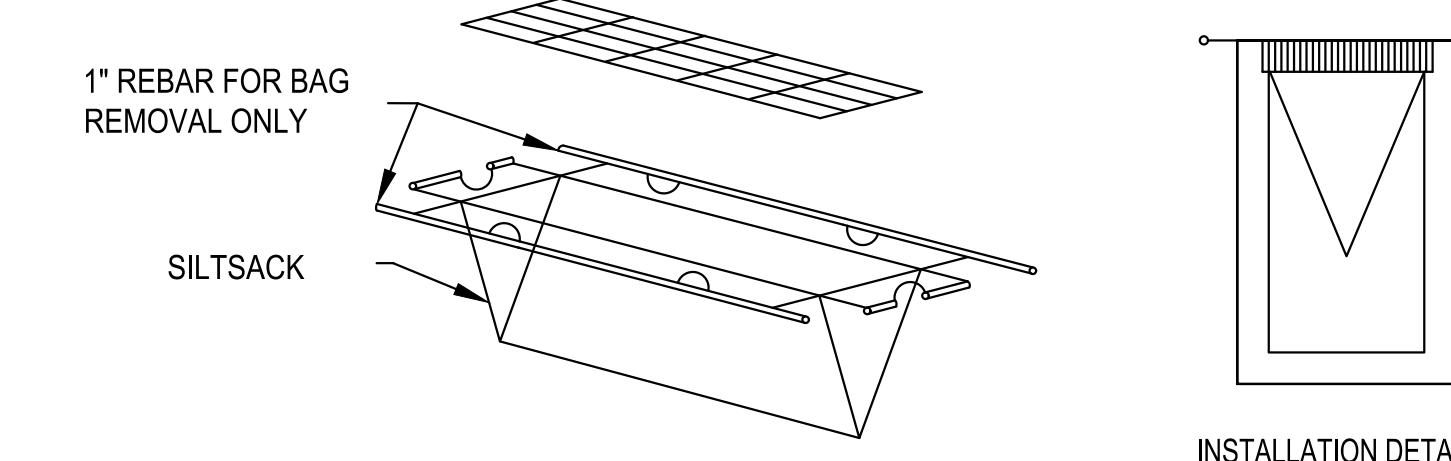
SCALE: 2" = 1'-0"


3 CONTROL JOINT

SCALE: 2" = 1'-0"


4 RESET STOCKPILED PRECAST CONCRETE UNIT PAVER

SCALE: 1" = 1'-0"



NOTES:

1. THE PRIMARY PURPOSE OF CATCH BASIN PROTECTION IS TO PREVENT SEDIMENT FROM ENTERING THE DRAINAGE SYSTEM BY PONDING WATER WHICH ALLOWS SEDIMENT TO FALL OUT OF SUSPENSION.
2. THE TOP OF THE INLET PROTECTION SHALL BE SET AT THE MAXIMUM DESIRED WATER LEVEL BASED ON FIELD LOCATION AND CONDITIONS.
3. SEDIMENT SHALL BE REMOVED WHEN ACCUMULATION REACHES ONE-THIRD OF THE STRUCTURE'S HEIGHT.

5 FILTER FABRIC INLET PROTECTION

SCALE: N.T.S.